

**GENERAL NOTES**

- ALL WORK SHALL COMPLY WITH ALL LOCAL, STATE AND NATIONAL CODES AND AGENCIES WHICH GOVERN THE WORK TO BE PERFORMED. UNLESS OTHERWISE STATED, OR WHERE MUNICIPAL CODES GOVERN, THE FOLLOWING CODES SHALL APPLY:
  - I.B.C. 2018, AS ADOPTED BY THE CITY OF JOPLIN, MO.
  - I.C.C. INTERNATIONAL PLUMBING CODE, LATEST EDITION.
  - I.C.C. INTERNATIONAL MECHANICAL CODE, LATEST EDITION.
  - NATIONAL ELECTRICAL CODE, LATEST EDITION.
  - INTERNATIONAL FIRE CODE, LATEST EDITION.
  - LIFE SAFETY CODE, LATEST ADDITION.
- CORNER GREER & ASSOCIATES ARCHITECTS, INC., IS NOT RESPONSIBLE FOR FIELD ACTIVITIES (MEANS, METHODS OR TECHNIQUES) ON THIS PROJECT.
- CONTRACTOR TO VISIT THE SITE AND FAMILIARIZE HIMSELF WITH ALL ON-SITE CONDITIONS. IF CONDITIONS ARE UNCOVERED THAT REQUIRE A CHANGE OR ADDITIONAL INFORMATION, THE ARCHITECT SHALL BE NOTIFIED IMMEDIATELY. THE ARCHITECT DOES NOT DELEGATE HIS AUTHORITY TO ANYONE ELSE FOR DETERMINING THE MEANING OF HIS PLANS OR SPECIFICATIONS.
- CONTRACTOR TO VERIFY ALL DIMENSIONS AND LOCATIONS OF EXISTING AND NEW CONDITIONS.
- CONTRACTOR TO VERIFY LOCATIONS OF ALL EXISTING UTILITIES AND MAKE CONNECTIONS THERE AND IN ACCORDANCE WITH ALL APPLICABLE CODES AND REQUIREMENTS. CONTRACTOR SHALL CONTACT ALL UTILITIES AND/OR AGENCIES.
- CONTRACTOR SHALL SECURE AND PAY FOR THE BUILDING PERMIT AND OTHER PERMITS AND GOVERNMENTAL FEES, LICENSES AND INSPECTIONS AS NECESSARY FOR PROPER EXECUTION AND COMPLETION OF THE WORK, INCLUDING ALL NECESSARY FEES ASSOCIATED WITH UTILITY CONNECTIONS.
- CONTRACTOR SHALL PROVIDE AND PAY FOR LABOR, MATERIALS, EQUIPMENT, TOOLS, CONSTRUCTION EQUIPMENT AND MACHINERY, WATER, HEAT, UTILITIES, TRANSPORTATION AND ANY OTHER FACILITIES AND SERVICES NECESSARY FOR PROPER EXECUTION AND COMPLETION OF THE WORK.
- THE CONTRACTOR SHALL CAREFULLY STUDY AND COMPARE THE CONTRACT DOCUMENTS WITH EACH OTHER AND WITH INFORMATION FURNISHED BY THE OWNER AND SHALL AT ONCE REPORT TO THE ARCHITECT, ERRORS, INCONSISTENCIES OR OMISSIONS DISCOVERED.
- THE ARCHITECT, CORNER GREER & ASSOCIATES ARCHITECTS, INC., SHALL BE RESPONSIBLE FOR THE ARCHITECTURAL PORTIONS OF THIS PROJECT. ALL OTHER ASPECTS SHALL BE THE RESPONSIBILITY OF REGISTERED PROFESSIONALS OF THAT DISCIPLINE.
- GENERAL CONDITIONS OF THE CONTRACT FOR CONSTRUCTION (AIA DOCUMENT A201) SHALL BE BINDING AS PART OF THESE CONSTRUCTION DOCUMENTS.
- ALL BUILDING FINISHES SHALL BE SELECTED AND/OR APPROVED BY THE OWNER'S REPRESENTATIVE.

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- ARCHITECTURAL**
- A101 FLOOR PLAN & DEMOLITION PLAN  
 A102 FINISH PLAN & REFLECTED CEILING PLAN & INTERIOR ELEVATIONS  
 A103 ENLARGED PLAN & ELEVATIONS

**PROJECT DESCRIPTION**

AN INTERIOR RENOVATION TO THE EXISTING LEVEL 01 RESTROOMS & ADJACENT CLASSROOM IN TAYLOR PERFORMING ARTS CENTER.

SCOPE OF WORK IS TO RENOVATE THE EXISTING RESTROOMS & ADJACENT CLASSROOM - REUSE EXISTING & ADD NEW FIXTURES, UPDATE FLOOR AND WALL FINISHES, ADD NEW INTERIOR WALLS AND DOORS, NEW ACT & GYP CEILING ASSEMBLIES, MODIFY & ADD TO EXISTING ELECTRICAL.

**AN INTERIOR RENOVATION for:**

**TAYLOR PERFORMING ARTS CENTER**

**LEVEL 01 RESTROOMS**



**3950 NEWMAN ROAD  
 JOPLIN, MO**

**CGA**

architecture  
 planning  
 design

Corner Greer & Associates, Inc.  
 716 S. Main Street  
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DATE: 03/09/2026  
 ARCHITECT: R CHAD GREER  
 #A-2009032804  
 CA: MO #000531

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revision description

rev date

rev no

AN INTERIOR RENOVATION for:

**TAYLOR PERFORMING ARTS CENTER**  
**LEVEL 01 RESTROOMS**

MISSOURI SOUTHERN STATE UNIVERSITY  
 JOPLIN, MO

ISSUE DATE  
**MARCH 9TH, 2026**  
 SHEET

**COVER SHEET**

SHEET NO.

**G001**


**SYMBOLS**

- 2/A401 SECTION MARK
- 2/A402 DETAIL MARK
- 2/A301 ELEVATION MARK
- WALL TYPES
- 100-1 DOOR MARK
- 2 WINDOW MARK

**MATERIALS**

- CONCRETE ( PLAN )
- CONCRETE ( SECTION )
- CONCRETE BLOCK BRICK
- MASONRY RIGID INSULATION
- BATT OR BLOWN INSULATION
- DIMENSIONAL LUMBER
- PLYWOOD
- FINISHED WOOD
- GYPSUM BOARD
- STUD WALL CONSTRUCTION

**LOCATION MAP**

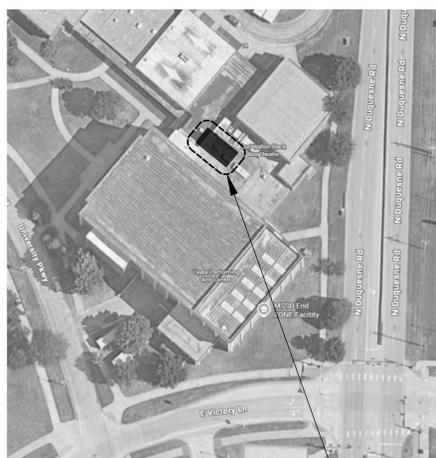

PROJECT LOCATION



**VICINITY MAP**



PROJECT LOCATION



**CODE COMPLIANCE**

CODE \_\_\_\_\_ 2018 I.B.C.  
 OCCUPANCY \_\_\_\_\_ B  
 CONSTRUCTION TYPE \_\_\_\_\_ II B  
 BUILDING AREAS \_\_\_\_\_ UNCHANGED  
 OCCUPANT LOAD \_\_\_\_\_ UNCHANGED  
 SPRINKLER SYSTEM \_\_\_\_\_ UNCHANGED  
 PARKING SPACES \_\_\_\_\_ UNCHANGED

SCOPE OF WORK IS A REPLACEMENT OF RESTROOM FIXTURES & FINISHES AS A "LEVEL 2 ALTERATION" DEFINED BY THE 2018 IEBC.



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**AN INTERIOR RENOVATION for:**  
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SHEET

**FLOOR PLANS**

SHEET NO.  
**A101**

**INTERIOR WALL TYPES LEGEND**

- (A) 3-5/8" METAL STUDS AT 16" O.C.  
5/8" GYPBD. CORRIDOR SIDE.  
5/8" MR BOARD RESTROOM SIDE.  
R-11 SOUND INSULATION.  
- EXTEND TO STRUCTURE ABOVE.
- (B) 3-5/8" METAL STUDS AT 16" O.C.  
5/8" GYPBD. EXPOSED SIDE.  
R-11 SOUND INSULATION.  
- EXTEND TO STRUCTURE ABOVE.
- (C) 6" METAL STUDS AT 16" O.C.  
5/8" GYPBD. EACH SIDE.  
R-11 SOUND INSULATION.  
- EXTEND TO STRUCTURE ABOVE.
- (D) 6" METAL STUDS AT 16" O.C.  
5/8" GYPBD. CORRIDOR SIDE.  
5/8" MR BOARD RESTROOM SIDE.  
R-11 SOUND INSULATION.  
- EXTEND TO STRUCTURE ABOVE.
- (E) 6" METAL STUDS AT 16" O.C.  
5/8" GYPBD. CLASSROOM SIDE.  
5/8" MR BOARD ON CHASE SIDE.  
R-11 SOUND INSULATION.  
- EXTEND TO STRUCTURE ABOVE.
- (F) 3-5/8" METAL STUDS AT 16" O.C.  
5/8" MR BOARD RESTROOM SIDE.  
R-11 SOUND INSULATION.  
- EXTEND TO STRUCTURE ABOVE.
- (G) 7/8" METAL FURRING AT 16" O.C.  
5/8" MR BOARD RESTROOM SIDE.  
- EXTEND 4" ABOVE CEILING.
- (H) 1-5/8" METAL FURRING AT 16" O.C.  
5/8" GYP BOARD CORRIDOR SIDE.  
- EXTEND 4" ABOVE CEILING.
- (J) 3-5/8" METAL STUDS AT 16" O.C.  
5/8" GYPBD. BOARD EACH SIDE.  
R-11 SOUND INSULATION.  
- EXTEND TO STRUCTURE ABOVE.
- (K) 4" NOMINAL C.M.U. INFILL OPENING.  
"TOOTH IN" TO ADJACENT MASONRY.


NOTE: LEVEL 5 FINISH AT GYPSUM WALLS / CEILINGS RECEIVING PAINT

**DOOR & FRAME SCHEDULE**

MK	DIM	DOOR TYPE	FRAME TYPE	DOOR TYPE	HDW TYPE	NOTE
102-1	36X84	B	HM	SCW	PAS	CLOSER
105-1	36X84	A	HM	SCW	CI	CLOSER
106-1	36X60	B	HM	SCW	STO	

NOTE: ALL DOORS TO BE PROVIDED W/ WALL STOPS. PROVIDE FLOOR STOPS WHERE WALLS STOPS ARE NOT FEASIBLE

**DOOR TYPES & FRAMES**

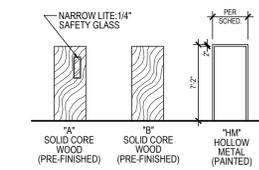

**DOOR HARDWARE LEGEND**

- HDW - HARDWARE
- STO - STORAGE
- CI - CLASSROOM INTRUDER
- EXT - EXTERIOR
- PAS - PASSAGE

**ABBREV. LEGEND**

- SCW - SOLID CORE WOOD
- HM - HOLLOW METAL

NOTE: CLASSROOM INTRUDER HARDWARE B.O.D. - EQUAL TO SCHLAGE ND75 XN12-035 X US26D X RHO W/ KEY ROTATION INDICATOR

**DOOR HARDWARE NOTES**

- THE HARDWARE INFORMATION PROVIDED ON THIS SHEET IS TO BE USED AS A BASIC GUIDE TO CONVEY "DESIGN INTENT". IT IS THE CONTRACTOR'S RESPONSIBILITY TO DEVELOP A MORE DETAILED HARDWARE SCHEDULE AS THE BASIS FOR FINAL PURCHASES AND INSTALLATIONS. IT IS PRESUMED THAT THE HARDWARE SCHEDULE WILL BE PREPARED BY AN EXPERIENCED AND KNOWLEDGEABLE HARDWARE CONSULTANT/SUPPLIER, AND THAT IT WILL INCLUDE THE FOLLOWING:
  - QUANTITY, MFRS, CATALOG #S, TYPES, SIZES, FINISH, AND ALL OTHER PERTINENT TECHNICAL INFORMATION.
  - COMPLETE LOCATION DESCRIPTION CROSS-REFERENCED WITH THE SUBMITTALS OF RESPECTIVE TYPES OF DOORS TO WHICH THE SPECIFIC HARDWARE WILL BE INSTALLED.
  - ANY AND ALL HARDWARE, ACCESSORIES, PARTS, COMPONENTS, ETC. FOR A COMPLETE INSTALLATION EVEN IF THIS REQUIRED ITEMS NOT SPECIFICALLY IDENTIFIED ON THESE DRAWINGS.
  - PROVIDE TEMPLATES TO THE NECESSARY TRADES TO PREPARE DOOR AND FRAMES FOR HARDWARE INSTALLATION.
  - PROVIDE ACTUAL PHYSICAL HARDWARE ITEMS WHEN TEMPLATES ARE NOT AVAILABLE.
  - ALL HARDWARE SHALL MATCH EXISTING IN FACILITY IN FINISH & TYPE - FIELD VERIFY.
  - G.C. TO VERIFY KEYING REQUIREMENTS WITH OWNER PRIOR TO ORDERING HARDWARE.

**CONSTRUCTION LEGEND**

- (Solid line) EXISTING WALLS, DOORS, SOFFITS, ETC., TYP.
- (Dashed line) DASHED LINES INDICATE EXISTING WALLS, DOORS, SOFFITS, ETC. TO BE REMOVED THROUGHOUT, TYP.
- (Thin solid line) NEW WALLS, DOORS, SOFFITS, ETC., TYP.

**CONSTRUCTION KEY**

- A. NEW PLATFORM STEP TO MATCH EXISTING.
- B. NEW ACCESS PANEL.
- C. NEW WALL MT TOILETS TO MATCH EXISTING. CONNECT TO NEAREST EXISTING 4" WASTE PIPING, 2" VENT PIPING AND 1" COLD WATER PIPING. FIELD VERIFY LOCATIONS PRIOR TO BEGINNING WORK.
- D. HATCH DENOTES EXISTING WALL TO REMAIN, TYP.
- E. EXISTING PLUMBING FIXTURE TO BE RE-INSTALLED ON NEW FURRED OUT WALL WHERE SHOWN. RECONNECT TO EXISTING WASTE, VENT, AND SUPPLY CONNECTIONS.
- F. NEW SINK, FAUCET, P TRAP & LAVATORY GUARD - SEE ENLARGED PLAN. RECONNECT TO EXISTING WASTE, VENT, AND SUPPLY CONNECTIONS.
- G. PROVIDE NEMA 5-20 RECEPTACLE AT 18" AFF. DERIVE CIRCUITRY FROM NEAREST EXISTING BRANCH CIRCUIT SERVING GENERAL USE RECEPTACLES. DO NOT EXCEED (9) GENERAL USE RECEPTACLES ON ANY GIVEN CIRCUIT.
- H. OVERHEAD PROJECTOR, MARKER-BOARD, PROJECTION SCREEN TO BE MOUNTED AT NEW LOCATIONS SHOWN.
- J. NEW URINALS INSTALLED ON NEW FURRED OUT WALL IN NEW LOCATIONS. RECONNECT TO EXISTING WASTE, VENT, AND SUPPLY CONNECTIONS.
- K. NEW SWITCH IN NEW LOCATION - USE EXISTING CIRCUIT. UTILIZE FOR CONTROL OF ROOM LIGHTING CIRCUIT.

**CONSTRUCTION NOTES**


- DIMENSIONS SHOWN ARE FROM EDGE OF STUD OR CMU (OR FOUNDATION WALL WHERE OCCURS) TO EDGE OF STUD
- GENERAL CONTRACTOR TO VERIFY ALL DIMENSIONS & NOTIFY ARCHITECT OF DISCREPANCIES PRIOR TO CONSTRUCTION
- GENERAL CONTRACTOR TO PROVIDE BLOCKING FOR SUPPORT OF RESTROOM ACCESSORIES AS RECOMMENDED BY MANUFACTURER

**DEMOLITION KEYED NOTES**


1. REMOVE DOOR, FRAME & HARDWARE.
2. PREP WALL FOR NEW DOOR, FRAME & HARDWARE.
3. REMOVE WALL - VERIFY AS NON STRUCTURAL.
4. REMOVE RESTROOM ACCESSORIES. SALVAGE & REINSTALL PER OWNER'S DIRECTION.
5. REMOVE CEILING SYSTEM, HVAC REGISTER & LIGHTING FIXTURES IN THEIR ENTIRETY. PREP FOR NEW CEILING FOR NEW FIXTURES.
6. REMOVE CLASSROOM PLATFORM TO EXTENTS INDICATED BY HATCH. G.C. TO PROVIDE SUPPLEMENTAL FRAMING FOR REMAINING PORTION OF STAGE.
7. REMOVE & REPLACE CEILING SYSTEM. PROTECT & RELOCATE LIGHTING & HVAC REGISTERS AS REQUIRED FOR CONSTRUCTION - REFER RCP.
8. MODIFY TERRAZZO WALL BASE TO ACCEPT NEW WALL - PREPARE WALL FOR NEW BASE IN ACCORDANCE WITH NEW FLOORING.
9. REMOVE PARTITIONS.
10. REMOVE SINKS - PREPARE FOR NEW WALL MOUNTED SINKS ON NEW FURRED OUT WALL. ASSOCIATED WASTE, VENT, AND SUPPLY PIPING TO REMAIN FOR NEW FIXTURES.
11. REMOVE ACCESS PANEL.
12. DE-MOUNT MARKER BOARD, PROJECTOR SCREEN, OVERHEAD PROJECTOR - PROTECT & REINSTALL AT NEW LOCATION.
13. REMOVE URINALS - PREPARE FOR NEW WALL MOUNTED FIXTURES ON NEW FURRED OUT WALL. ASSOCIATED WASTE, VENT AND SUPPLY PIPING TO REMAIN FOR REINSTALLATION.
14. REMOVE & PROTECT TOILETS - PREPARE FOR NEW WALL MOUNTED FIXTURES ON NEW FURRED OUT WALL. ASSOCIATED WASTE, VENT AND SUPPLY PIPING TO REMAIN FOR REINSTALLATION.
15. REPLACE DRAIN TRIM W/ DRAIN HIT EXTENSION KIT TO ALIGN WITH NEW FLOOR TILE HT.

**DEMOLITION NOTES**

- IMPORTANT: THE DEMOLITION PLAN IS PROVIDED AS A REFERENCE DRAWING TO ILLUSTRATE EXISTING CONDITIONS INTO WHICH THE DESIGN WILL BE INCORPORATED. THIS DRAWING SHOULD NOT BE CONSTRUED AS AN "AS-BUILT" DRAWING OR A COMPREHENSIVE RECORD OF ALL CONDITIONS THAT WILL IMPACT INSTALLATION OF THIS DESIGN, NOR SHOULD IT BE UNDERSTOOD TO BE A COMPLETE INDICATION OF ALL ITEMS REQUIRED TO BE REMOVED OR DEMOLISHED IN ORDER TO EXECUTE THIS DESIGN. IT IS THE CONTRACTOR'S RESPONSIBILITY TO EXAMINE THE SITE PRIOR TO CONSTRUCTION TO CONFIRM & VERIFY EXISTING CONDITIONS & DETERMINE THE FOLLOWING:
  - IF ANY ADDITIONAL DEMOLITION WORK WILL BE REQUIRED TO ACHIEVE THIS DESIGN.
  - IF EXISTING ELEMENTS, UTILITIES, BUILDING FEATURES, ETC. WILL INTERFERE WITH THE EXECUTION OF THIS DESIGN AS SHOWN.
  - IF ANY OF THE EXISTING CONDITIONS, MATERIALS, UTILITIES, OR OTHER ITEMS CAN BE USED (OR REUSED) & INCORPORATED INTO THIS DESIGN.
  - IF ANY ELEMENTS SCHEDULED FOR DEMO ARE DISCOVERED OR SUSPECTED TO BE STRUCTURAL IN NATURE, CONTRACTOR SHALL NOTIFY ARCHITECT IMMEDIATELY FOR DIRECTION PRIOR TO PROCEEDING WITH WORK.
- CONTRACTOR SHALL REMOVE & DISPOSE OF ALL CONSTRUCTION DEBRIS IN ACCORDANCE WITH LOCAL, STATE & FEDERAL REQUIREMENTS, & IN ACCORDANCE WITH THE OWNER'S CONSTRUCTION CRITERIA.
- AREAS IN WHICH DEMOLITION & SALVAGE WORK IS BEING DONE SHALL BE CLEANED DAILY. ALL DIRT, DUST, DEBRIS, UNSALVAGEABLE & ITEMS NOT TO BE REUSED SHALL BE TOTALLY REMOVED FROM THE PROJECT SITE DAILY.
- DURING REMOVAL OF ITEMS BEING SALVAGED, CAUTION SHALL BE USED TO ELIMINATE POSSIBILITY OF DAMAGE TO SUCH ITEMS. ALL REUSEABLE ITEMS SALVAGED DURING DEMOLITION OPERATIONS SHALL BE RETAINED FOR THE OWNER'S INSPECTION. ONLY ITEMS PROPERLY INSPECTED & REJECTED BY THE OWNER SHALL BE DISPOSED. ALL OTHER ITEMS SHALL BE TURNED OVER TO THE OWNER FOR DISPOSITION.
- WHERE ELEMENTS ARE SCHEDULED TO BE REMOVED THAT MAY CONTAIN EXISTING POWER, WIRING, OUTLETS, LIGHTING, SWITCHES, OR OTHER DEVICES OR COMPONENTS, G.C. IS TO TAKE CARE TO PROPERLY & ADEQUATELY REMOVE, RELOCATE OR DISABLE ELEMENTS NOT NECESSARY FOR OPERATION. THIS ALSO APPLIES TO REMOVAL OF ITEMS CONTAINING PLUMBING OR OTHER UTILITY COMPONENTS THAT WILL NEED TO BE PROPERLY DISABLED OR "CAPPED".
- WHERE FLOOR, WALL OR CEILING ITEMS ARE REMOVED, G.C. IS TO PATCH, REPAIR, RECONSTRUCT OR OTHERWISE PREP AFFECTED AREA TO RECEIVE NEW MATERIALS OR FINISHES AS INDICATED IN THESE PLANS.
- COMMENCEMENT OF WORK INDICATES THAT THE SUB-SURFACE MEETS THE CONDITIONS AS OUTLINED ABOVE.
- G.C. TO COORDINATE ALL DEMOLITION WORK WITH OWNER, INCLUDING, BUT NOT LIMITED TO, DUMPSTER LOCATION, STAGING AREAS, PARKING, ETC.
- ANY HAZARDOUS MATERIAL FOUND SHALL BE REPORTED TO THE OWNER & REMOVED BEFORE COMMENCEMENT OF CONSTRUCTION.
- PRIOR TO DEMOLITION, ELECTRICAL SUBCONTRACTOR SHALL DISCONNECT ALL ELECTRICAL CIRCUITS SERVING THE EXISTING SPACE EXCEPT FIRE ALARM &/OR SMOKE DETECTORS. MARK ALL CIRCUITS THAT REMAIN.
- G.C. TO TERMINATE & CAP ALL WIRING & CONDUIT THAT IS NOT BEING REUSED OR RELOCATED.
- PROVIDE MULTI-PURPOSE DRY CHEMICAL TYPE FIRE EXTINGUISHER(S) IN LOCATIONS & QUANTITIES FOR ENTIRE FACILITY AS DIRECTED BY LOCAL OFFICIALS. SEE PLAN FOR LOCATIONS IF APPLICABLE.

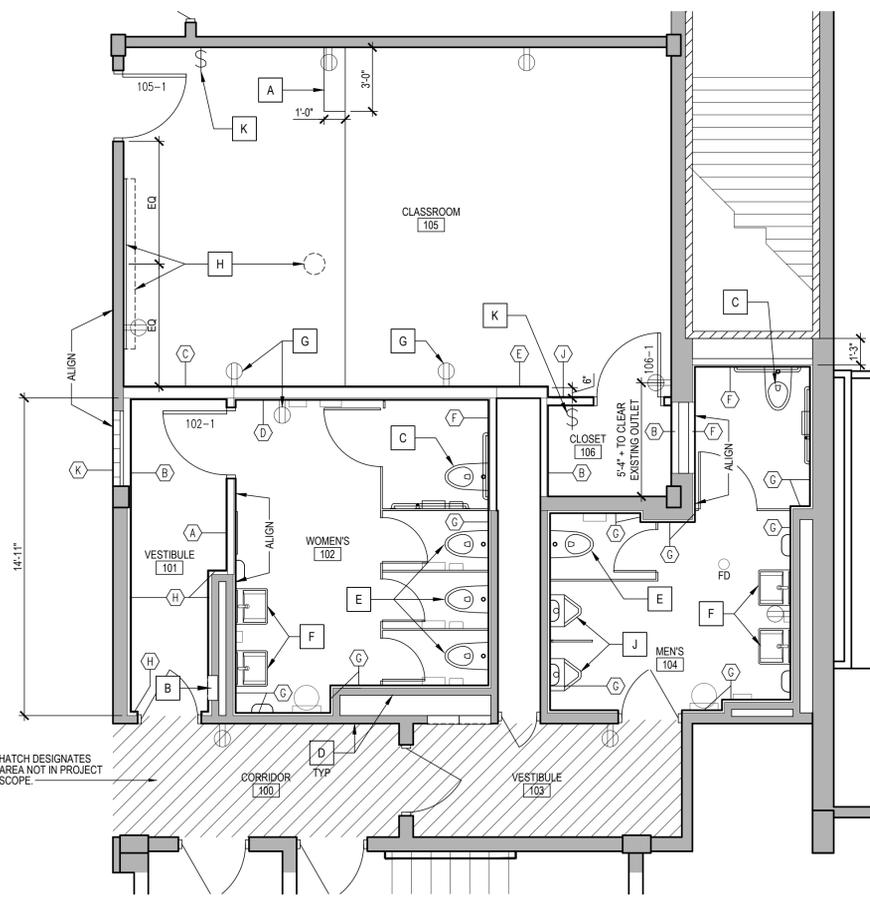

**2 FLOOR PLAN**  
Scale: 1/4" = 1'-0"

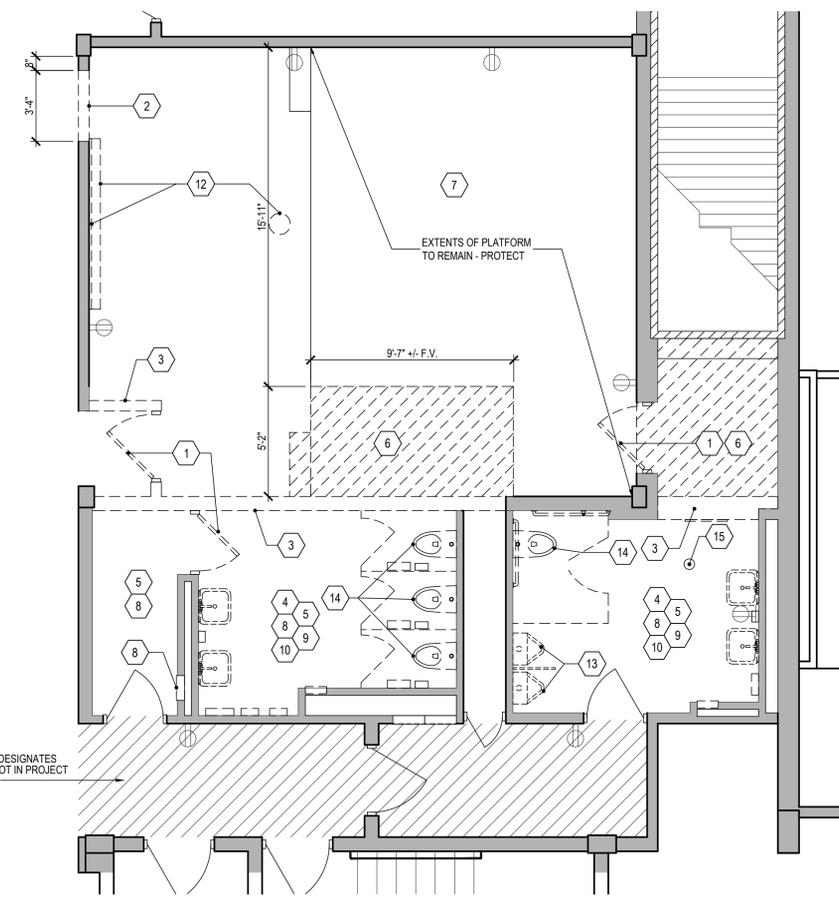


**1 DEMOLITION FLOOR PLAN**  
Scale: 1/4" = 1'-0"





### FIXTURE MOUNTING HEIGHTS AND CLEARANCES

NOTE: ALL ITEMS SHOWN ARE NOT NECESSARILY USED ON THIS PROJECT.

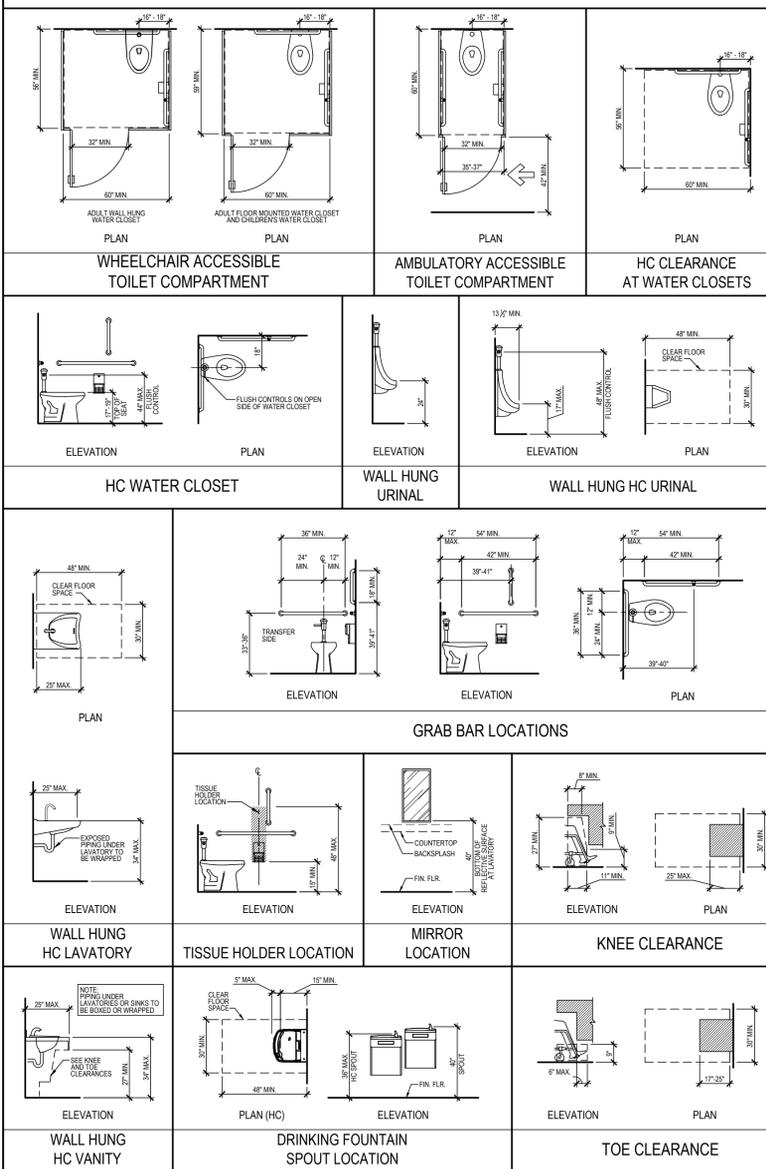

**NOTES:**  
 - PROVIDE 2x6 BLOCKING AT ALL GRAB BARS.  
 - PROVIDE BLOCKING AT ALL FIXTURES AS REQUIRED.  
 - PROVIDED BLOCKING AT LOCATIONS WHERE WALL STOPS FOR DOORS ARE SPECIFIED. REFER DOOR HARDWARE SPECIFICATIONS FOR ADDITIONAL INFORMATION.  
 - SIGNAGE, INCLUDING HANDICAP SYMBOL WHERE NECESSARY, IN COMPLIANCE W/ ADA REQUIREMENTS & CONFORM TO MSSU STANDARD.

### PLUMBING LEGEND & NOTES

LAV	WALL MT LAVATORY & FAUCET	AMERICAN STANDARDS DECORUM 20 X 18.25" WALL HUNG LAVATORY W/ EVERCLEAR - CENTER HOLE (9024.001EC) - INSTALL W/ DELTA 22C641 SINGLE HOLE, SINGLE HANDLE W/ GRID STRAINER
WC	NEW TOILET	AMERICAN STANDARD 2257 & ZER6000AV-DF-TM
WE	EXISTING TOILET	INSTALL NEW VALVE - ZER6000AV-DF-TM - ON EXISTING FIXTURES. G.C. TO VERIFY COMPATIBLE WITH EXISTING FIXTURES PRIOR TO ORDERING.
UR	URINAL	AMERICAN STANDARD 6581 & ZER6003AV-ULF-TM


**NOTES:**  
 - EXISTING TOILETS SHALL BE REUSED, G.C. TO PROVIDE NEW FLUSH VALVES AS SPECIFIED.  
 - URINALS & VALVES SHALL BE NEW AS SPECIFIED.  
 - COORDINATE THE ROUGH-IN OF ALL PLUMBING FIXTURES W/ EXISTING CONDITIONS TO MEET INTENDED LAYOUT.  
 - PROVIDE TRUEBRO HANDI-LAV-GUARD INSULATION KIT WHERE PLUMBING IS EXPOSED.  
 - PROVIDE SUPPORT FOR STRUCTURE AS RECOMMENDED BY MANUFACTURER.

### TOILET ACCESSORY LEGEND

GB-1	GRAB BAR (18" VERTICAL)	PER MT HTS	BOBRICK B5806 18
GB-2	GRAB BAR (42")	PER MT HTS	BOBRICK B5806 36
GB-3	GRAB BAR (36")	PER MT HTS	BOBRICK B5806 42
MIR-1	MIRROR (18x36)	PER MT HTS	BOBRICK B290 1836
MIR-2	MIRROR (24x72)	PER ELEV.	BOBRICK 6290 2472
SH	SHELF BRADLEY	PER ELEV.	ELVARI 782 818 2 BS
SD	SOAP DISPENSER	PER MT HTS	BY OWNER
PTD	PAPER TOWEL DISPENSER	PER MT HTS	BY OWNER
SND	SANITARY NAPKIN DISPOSAL	PER MT HTS	BY OWNER
TTD	TOILET PAPER DISPENSER	PER MT HTS	BY OWNER
ND	NEEDLE DISPOSAL	PER ELEV.	BY OWNER
SNV	SANITARY NAPKIN VENDOR	PER ELEV.	BY OWNER
TR	TRASH		BY OWNER

PARTITIONS TO BE OVERHEAD BRACED, PHENOLIC PARTITIONS IN SHALE - SUBMIT COLORS TO ARCHITECT FOR FINAL APPROVAL.  
**NOTES:**  
 - EXISTING ACCESSORIES TO BE REMOVED AND REINSTALLED BY G.C.  
 - COAT HOOKS TO BE PROVIDED INSIDE EACH TOILET STALL - REFER SPECS.

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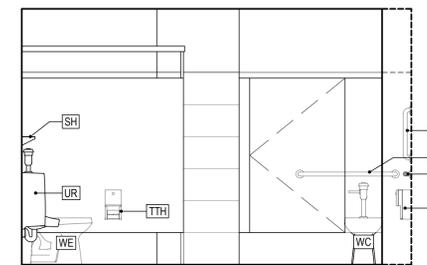
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 LEVEL 01 RESTROOMS  
 MISSOURI SOUTHERN STATE UNIVERSITY  
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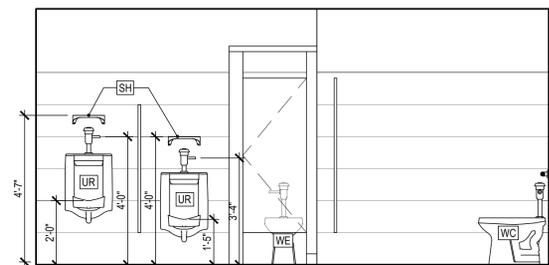
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**ENLARGED PLANS**

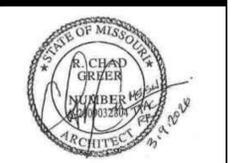
SHEET NO.  
**A103**




**8 RESTROOM ELEVATION RM 104**  
 Scale: 3/8" = 1'-0"




**7 RESTROOM ELEVATION RM 104**  
 Scale: 3/8" = 1'-0"

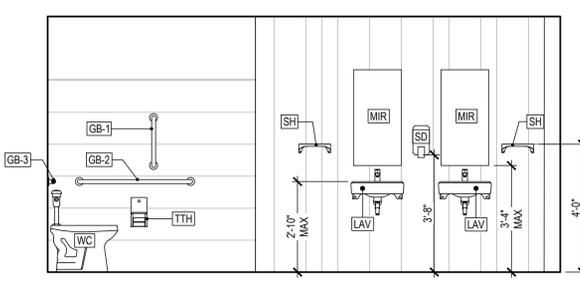

**6 RESTROOM ELEVATION RM 104**  
 Scale: 3/8" = 1'-0"

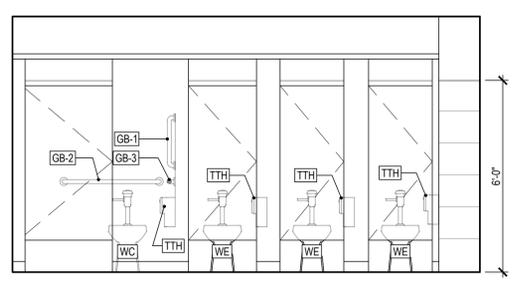


**5 RESTROOM ELEVATION RM 102**  
 Scale: 3/8" = 1'-0"

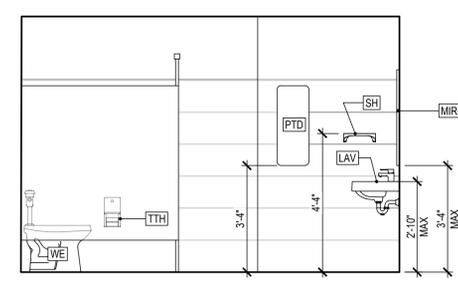

**4 RESTROOM ELEVATION RM 102**  
 Scale: 3/8" = 1'-0"


INSTALL "PTD" AT SAME HT IN MEN'S RR

TYPICAL NOTES - REFER TO A102 FOR FINISHES

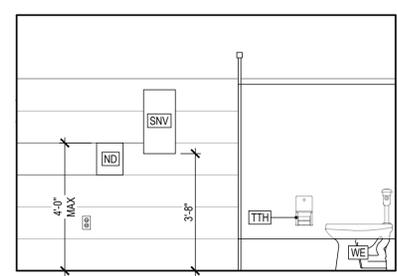


INSTALL "ND" AT SAME HT IN MEN'S RR

**3 RESTROOM ELEVATION RM 102**  
 Scale: 3/8" = 1'-0"

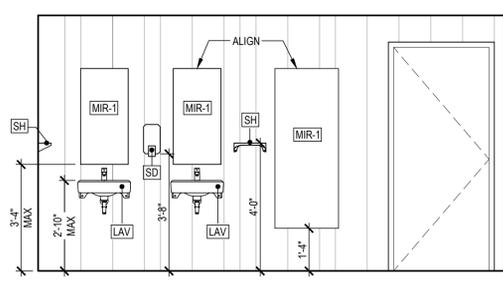

**2 RESTROOM ELEVATION RM 102**  
 Scale: 3/8" = 1'-0"

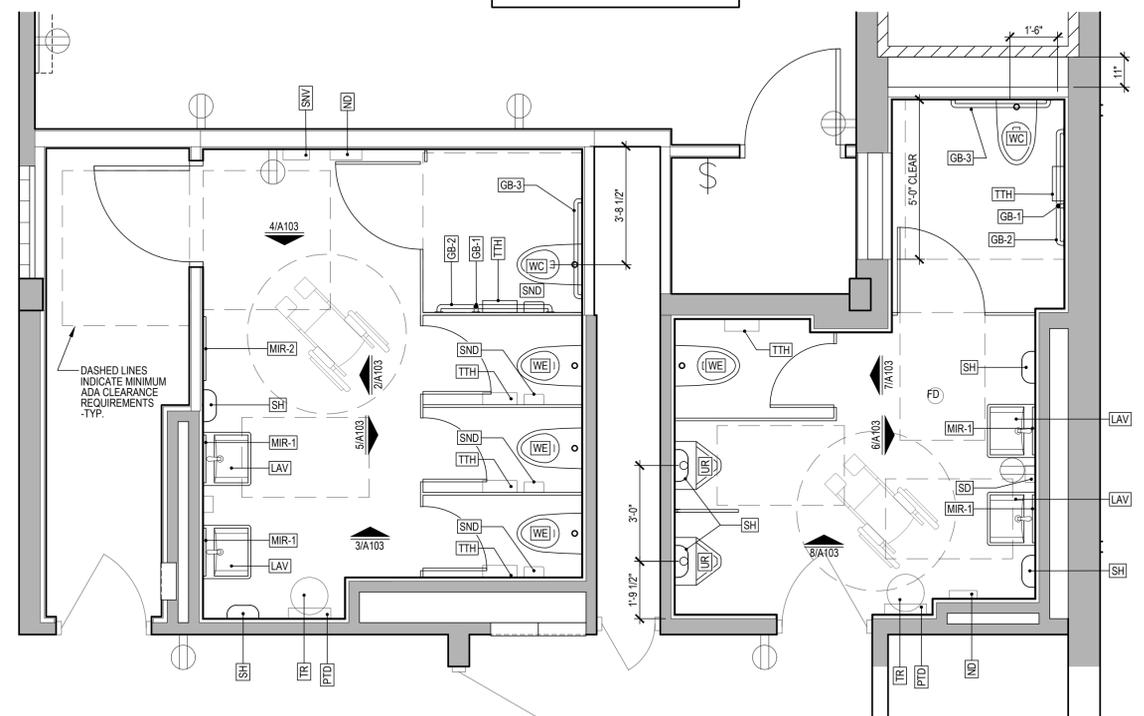

**1 ENLARGED FLOOR PLAN**  
 Scale: 3/8" = 1'-0"

